# PENNSYLVANIA GAME COMMISSION PROJECT NO. PGC-075-22-01 STATE GAME LANDS #075

## NEW 40' x 100' CREW HEADQUARTERS BUILDING

PINE TOWNSHIP, LYCOMING COUNTY, PENNSYLVANIA

CONTRACT NO. 1: GENERAL CONSTRUCTION CONTRACT NO. 3: PLUMBING CONSTRUCTION CONTRACT NO. 4: ELECTRICAL CONSTRUCTION

#### SITE PLAN GENERAL NOTES: EXTERIOR DISCONNECT AS REQUIRED FOR FEED FROM NEW BUILDING -EXISTING ABOVE GROUND UTILITY LINE LOCATIONS SHOWN ON THE DRAWINGS ARE APPROXIMATE. EXISTING WELL LOCATION -UNDERGROUND TELEPHONE, ELECTRIC, GAS, SANITARY SEWER, WATER AND STORMWATER DRAINAGE LINES MAY BE PRESENT AT SOME WORK LOCATIONS. FIELD VERIFICATION IS REQUIRED PRIOR TO ANY CONSTRUCTION. CONTACT PA ONE CALL GUARD RAILS AND FUEL AND COMPLY WITH ACT 287 (AS AMENDED) REGARDING LOCATIONS OF TANK LOCATION. ALONG GALLON SEPTIC TANK UNDERGROUND UTILITIES. SEEPAGE BED EXISTING CREW 2. ALL WORK WITHIN THE PUBLIC RIGHT-OF-WAY SHALL BE CONDUCTED IN ACCORDANCE WOODED AREA -WITH THE REQUIREMENTS OF PENNDOT, THE LOCAL MUNICIPALITY AND THE CONTRACT DOCUMENTS. - PROPOSED NEW SAMITARY LINE STORAGE SHED GRASS AREA -TO EXISTING SEPTIC TANK. SLOPE 3. CONTRACTOR SHALL COORDINATE WITH AFFECTED UTILITY COMPANIES IN THE EVENT MINIMUM 1/4" PER FT. CONNECT ITEMS SUCH AS TEMPORARY POLE SUPPORT IS REQUIRED. THIS WORK SHALL BE COMPLETED AT NO ADDITIONAL COST TO THE OWNER. TO POLE AND BUILD SUB-PANEL. 4. EXISTING DRAINAGE FACILITIES SHALL REMAIN INTACT DURING CONSTRUCTION. WITH UNDERGROUND EL UNLESS OTHERWISE DIRECTED BY THE ENGINEER. LIGHT TO BE REMOVED BY UTILITY PARKING AREA BY UTILITY COMPANY. EXISTING OVERHEAD ELECTRICAL ACCORDANCE WITH THE CONTRACT DOCUMENTS TO THEIR ORIGINAL CONDITION OR EXTEND EXISTING STONE PARKING -POWER SUPPLY LINE FROM POLE AREA WITH 4" THICK LAYER OF 2A (TRI-COUNTY RURAL ELECTRIC TO STORAGE BUILDING ELECTRIC COURSE AGGREGRATE OVER COOPERATIVE, Inc) SUB-PANEL. GRADED SUBBASE. 545\52\6 WITH POLE MOUNTED PROVIDE NEW UNDERGROUND (U.G. 6. ALL DISTURBED AREAS NOT RECEIVING OTHER SURFACE TREATMENT SHALL BE RANSFORMER TO BE REMOVED BY 4/OAWG ELECTRIC POWER SUPPLY FEED TO EXTEND EXISTING STONE PARKING -GRADED. SEEDED. AND MULCHED. EXISTING 200 AMP ELECTRIC PANEL TILITY COMPANY. ISTING STORAGE AREA WITH 4" THICK LAYER OF 2A SERVICE IN 21/2" Ø SCHEDULE 40 CONDUIT BUILDING — COURSE AGGREGRATE OVER FROM NEW DISCONNECT. (APPROX. 7. CONTRACTOR SHALL REFER TO CONTRACT DOCUMENTS FOR SOIL EROSION \$ 5B231 PREPARED SUBGRADE. SEDIMENTATION CONTROL PLAN REQUIREMENTS. NEW PROPOSED WELL LOCATION PROPOSED NEW CREW HQ. BUILDING -NEW UNDERGROUND I 1/4" Ø SCHEDULE 40 4,000 S.F. 8. MAINTAIN ACCESS TO DRIVEWAYS AND ENTRANCES LOCATED ALONG THE PROJECT. CONDUIT FROM NEW POLE TO NEW BUILDING F.F. ELEV. -100.13 LOCATION. FOR FUTURE VOICE/DATA SERVICE. STORAGE 9. THE CONTRACTOR SHALL ENSURE THAT ALL CONSTRUCTION VEHICLES (INCLUDING SHED/STRUCTURE —NEW UNDERGROUND (U.G.) ELECTRIC SERVICE EXISTING MATERIAL SUPPLIER VEHICLES) LEAVING THE PROJECT AREA HAVE MUD BUILDUP IN 3" Ø SCHEDULE 40 CONDUIT FROM NEW PARKING AREA REMOVED FROM THE TIRES BEFORE EXITING ONTO PAVED ROADWAYS. ALL MUD POLE MOUNTED TRANSFORMER TO NEW 400 TRACKED ONTO PAVED ROADWAYS SHALL BE IMMEDIATELY REMOVED FROM THE AMP SERVICE METER & PANEL AT NEW CREW HDQ. BUILDING. (APPROX. 165') ROADWAY. 100'-0" CEMETERY ROAD —STONE DRIVE CONSTRUCTED FROM 4" THICK LAYER OF 24'-0" 2A COURSE AGGREGRATE TOP COURSE OVER 4" THICK LAYER OF 3A MODIFIED BASE COURSE OVER PREPARED SUBGRADE. DRAWING INDEX NEW 15"Ø X 30' CORRUGATED HDPE CULVERT -PIPE WITH SMOOTH INTERIOR CS-I COVER SHEET & BUILDING SITE PLAN COMPLETE WITH HDPE A-I BUILDING FLOOR PLAN 4" THICK LAYER OF COMPACTED 2A FLARED END SECTIONS, A-2 ELEVATIONS. SCHEDULES & REFLECTED CEILING PLAN COURSE AGGREGRATE. SITE TYPICAL FOR BOTH ENDS. A-3 WALL SECTION & DETAILS SEE CULVERT PIPE DETAIL. A-4 SECTIONS & DETAILS COURSE OVER PREPARED SUBGRADE. P-I PLUMBING FLOOR PLAN, ELEVATIONS & DETAILS 15"Ø X 30' CORRUGATED HDPE CULVERT M-I MECHANICAL FLOOR PLAN & DETAILS PIPE WITH SMOOTH INTERIOR. PROVIDE MINIMUM 2% SLOPE DIRECTIONAL TO E-I ELECTRICAL FLOOR PLAN. SCHEDULES & DETAILS WATER DRAINAGE FLOW. PENNSYLVANIA GAME COMMISSION BACKFILL AROUND NEW CULVERT PIPE. STATE GAME LANDS # 075 NEW 40' x 100' CREW HEADQUARTERS BUILDING

I '-O"

SCALE: | " = | '-0"

CULVERT PIPE DETAIL

/ PROFESSIONAL

AUSTIN D. KIEFFER

COVER SHEET & BUILDING SITE PLAN

DRAWN BY:

SHEET NO.

PROJECT NO. PGC-075-22-01

M. SPOTTS

CS-I


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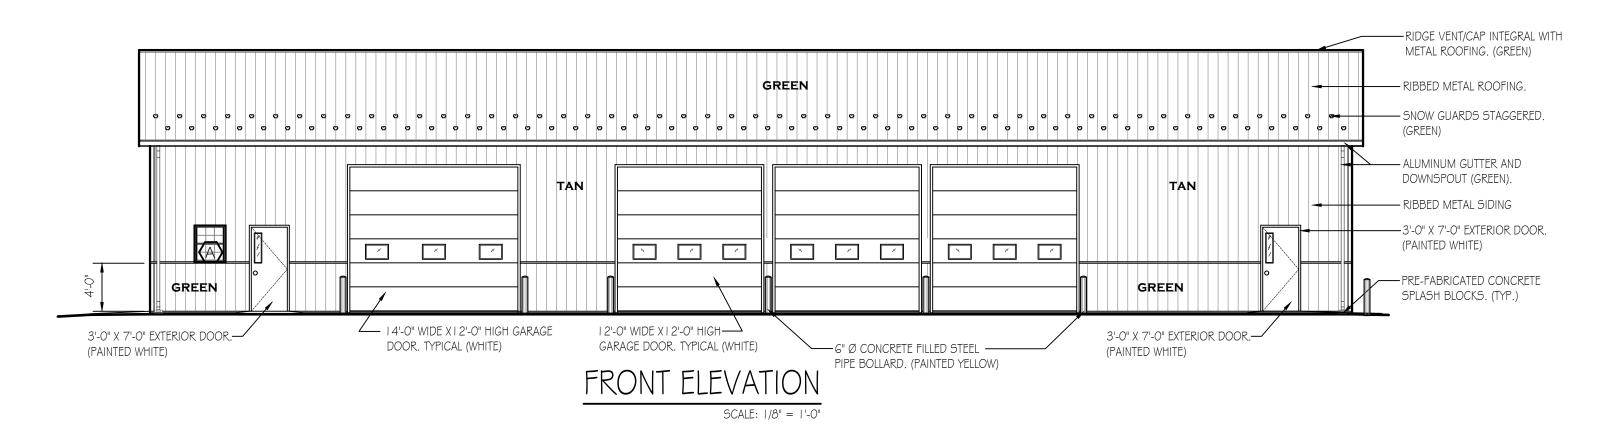
REVISIONS





PROJECT VICINITY MAP


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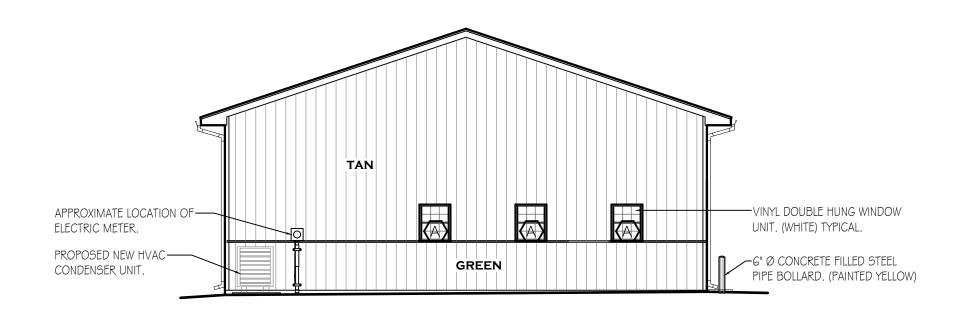




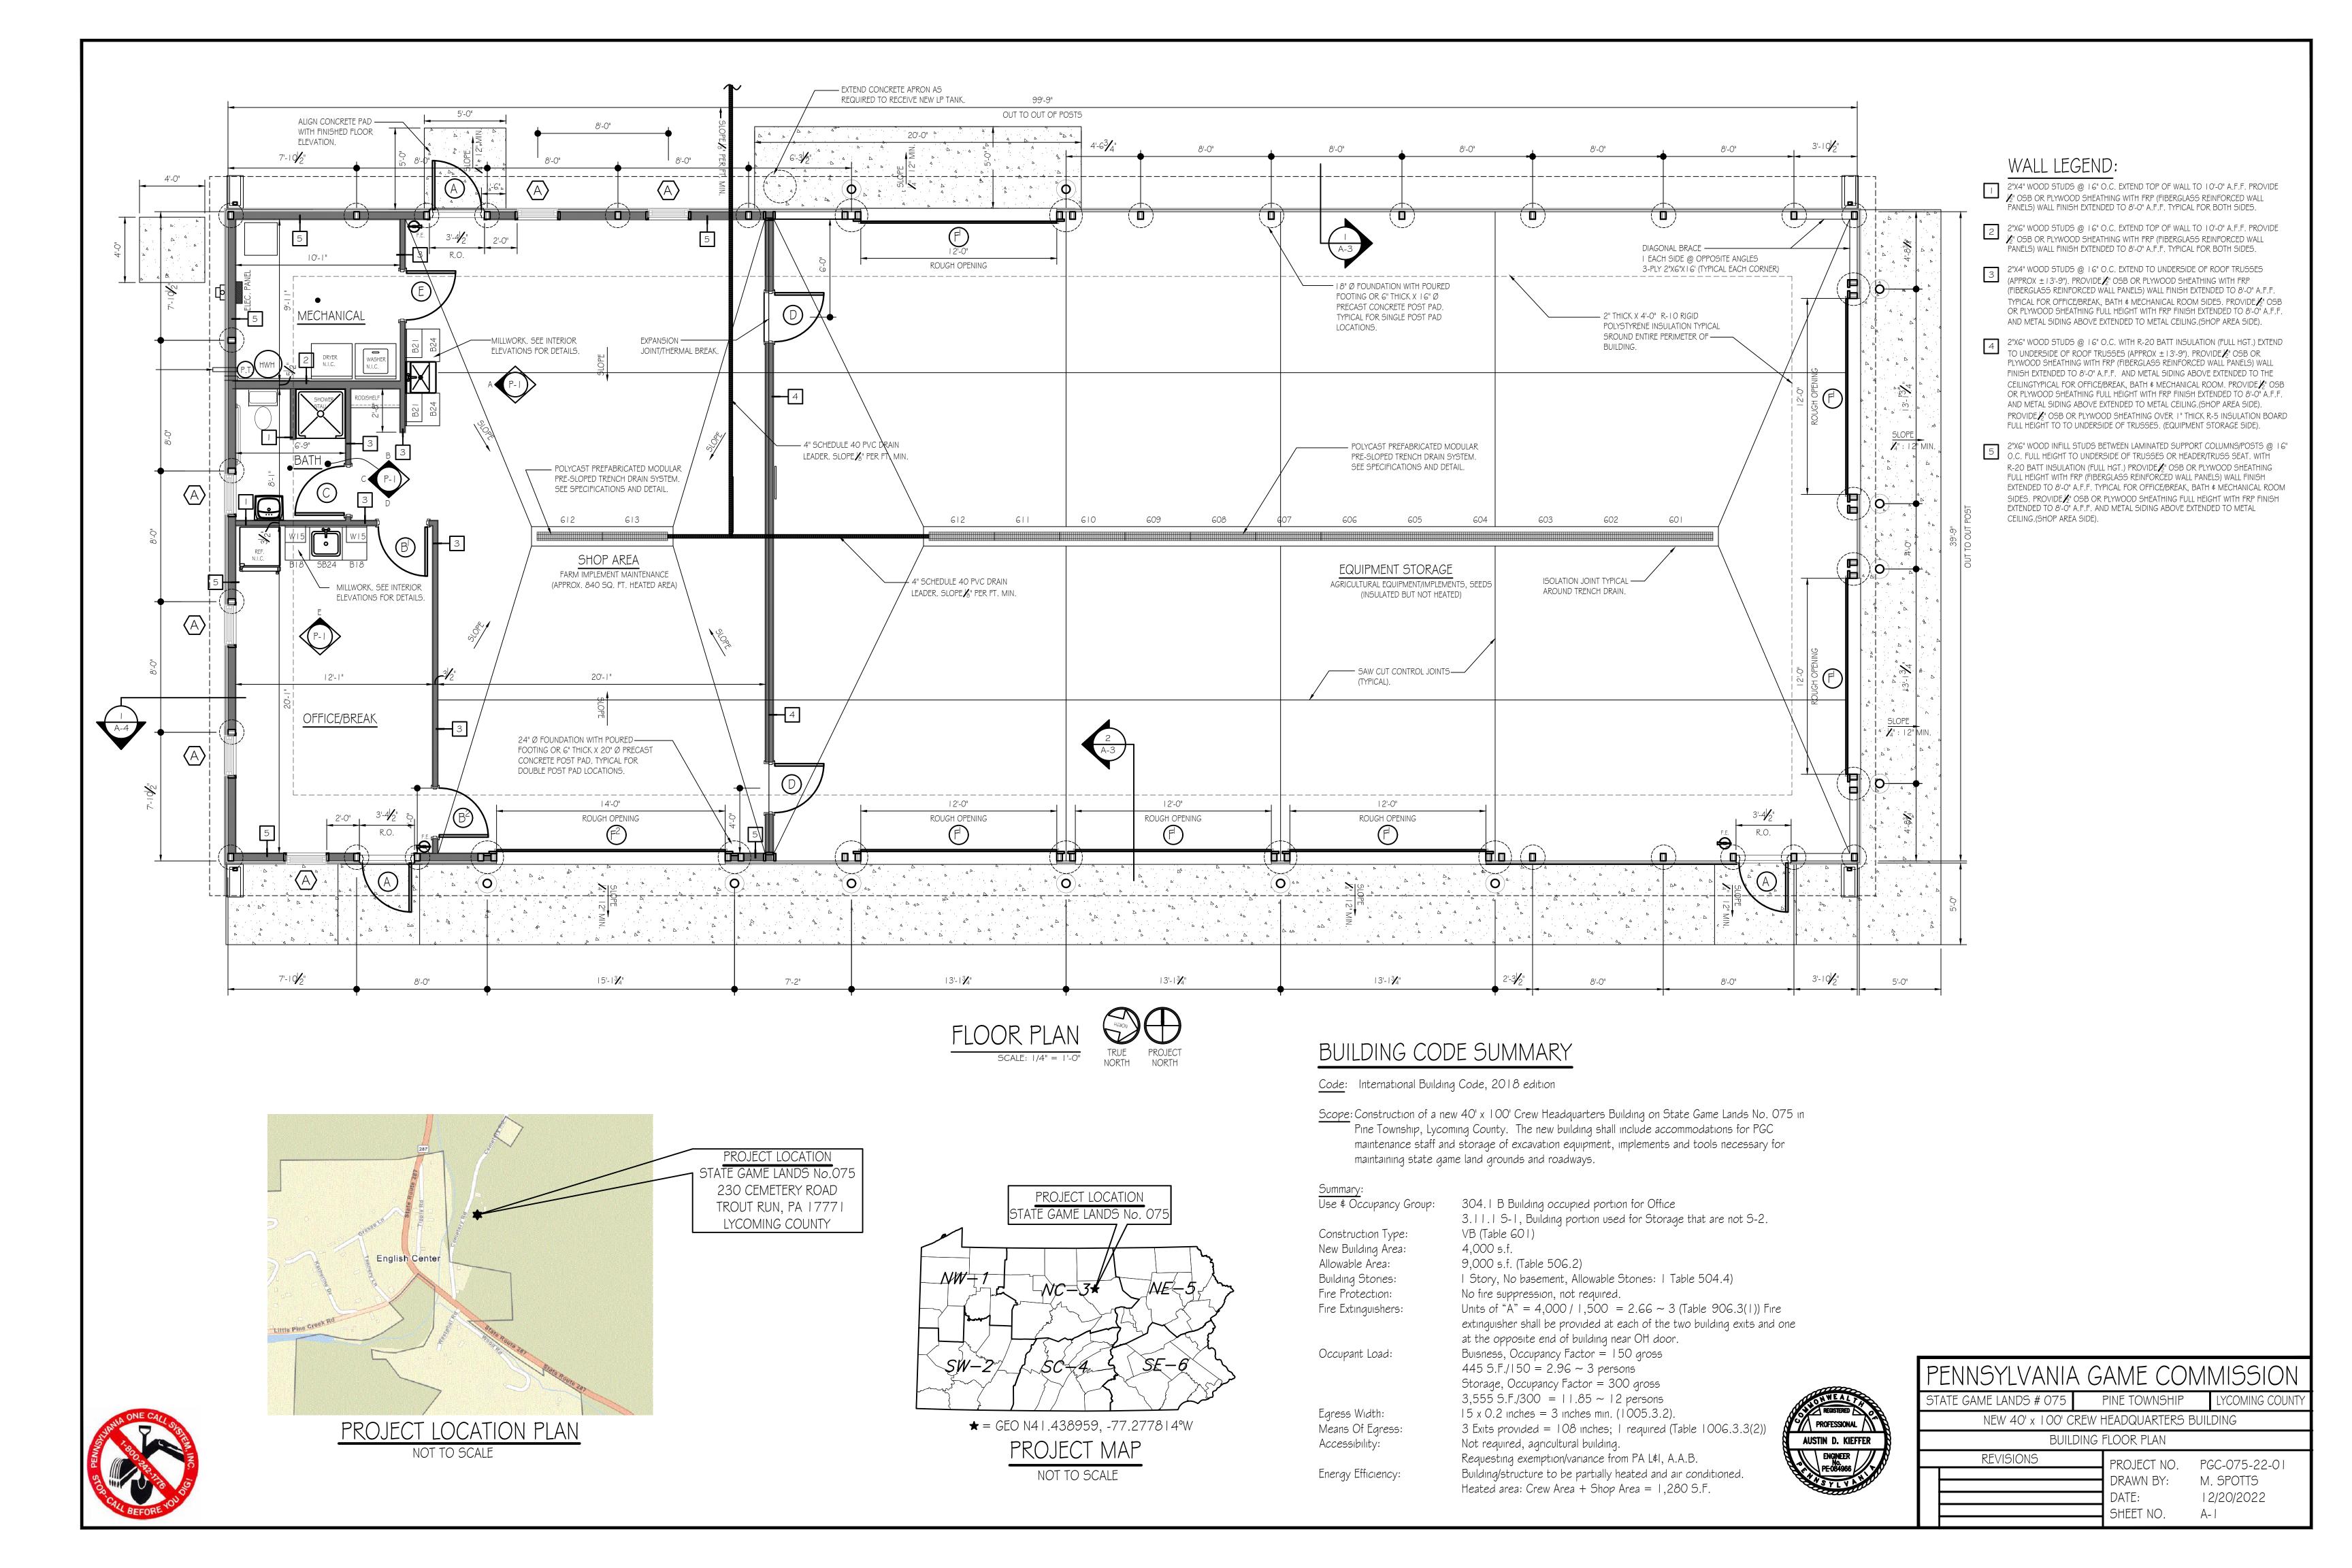


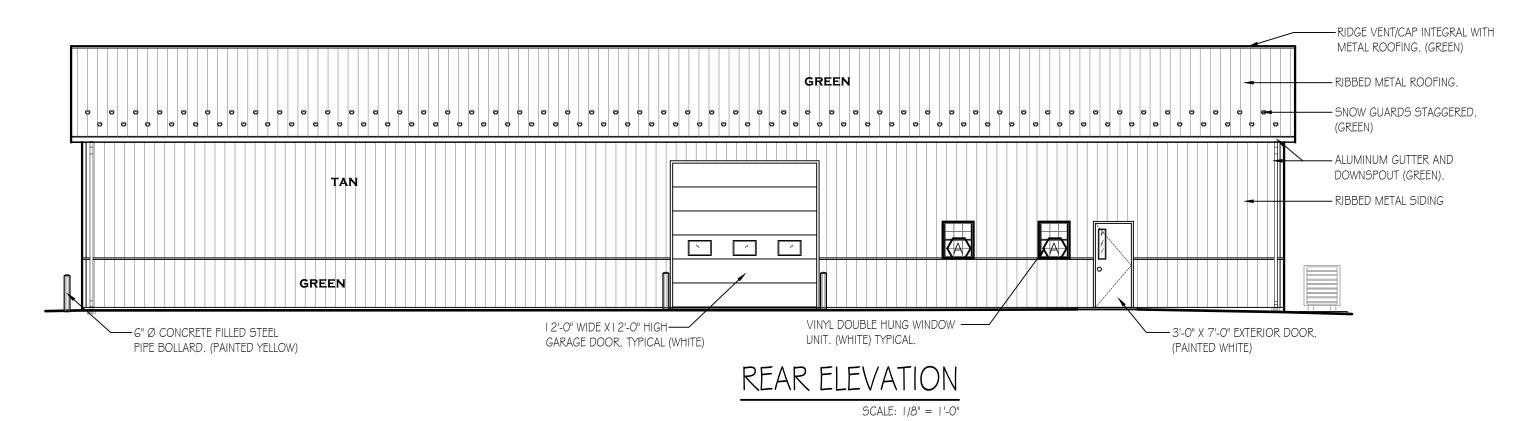TYPE I

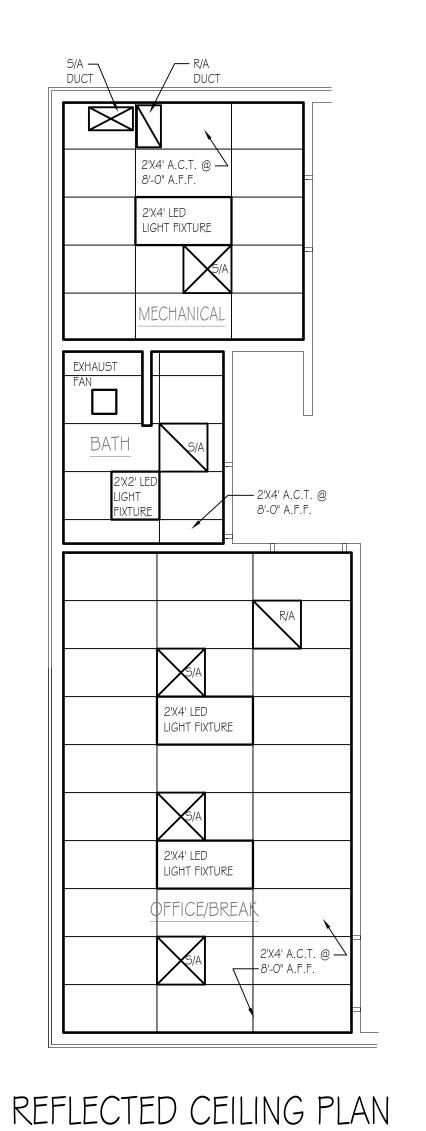TYPE 2

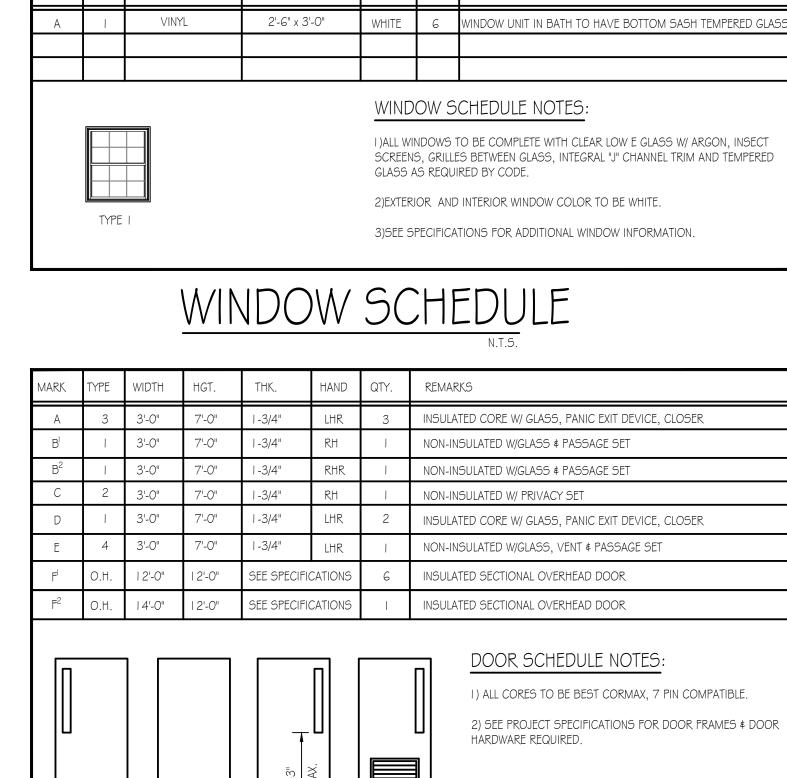

### RIGHT ELEVATION

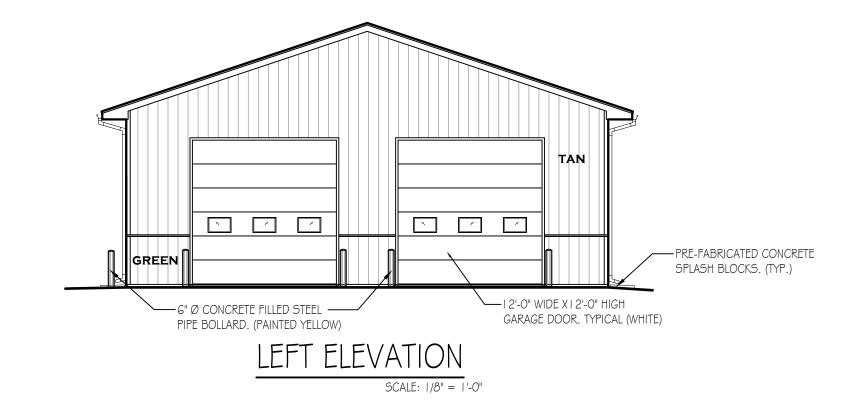

DOOR SCHEDULE





	PENNSYLVANIA GAME COMMISSION						
	STATE GAME LANDS # 075		PINE TOWNSHIP	LYCOMING COUNTY			
	NEW 40' x 100' CREW HEADQUARTERS BUILDING						
	ELEVATIONS, SCHEDULES & REFLECTED CEILING PLAN						
	REVISIONS		PROJECT NO.	PGC-075-22-01			
			DRAWN BY:	M. SPOTTS			


SHEET NO.

12/20/2022

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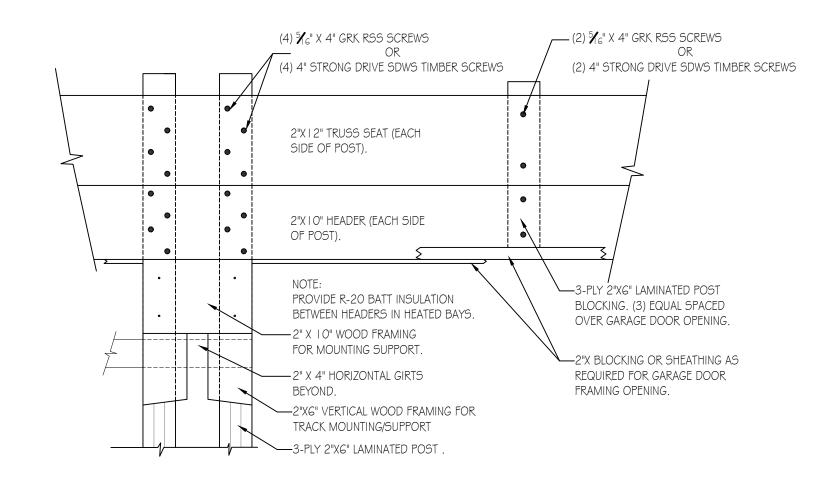


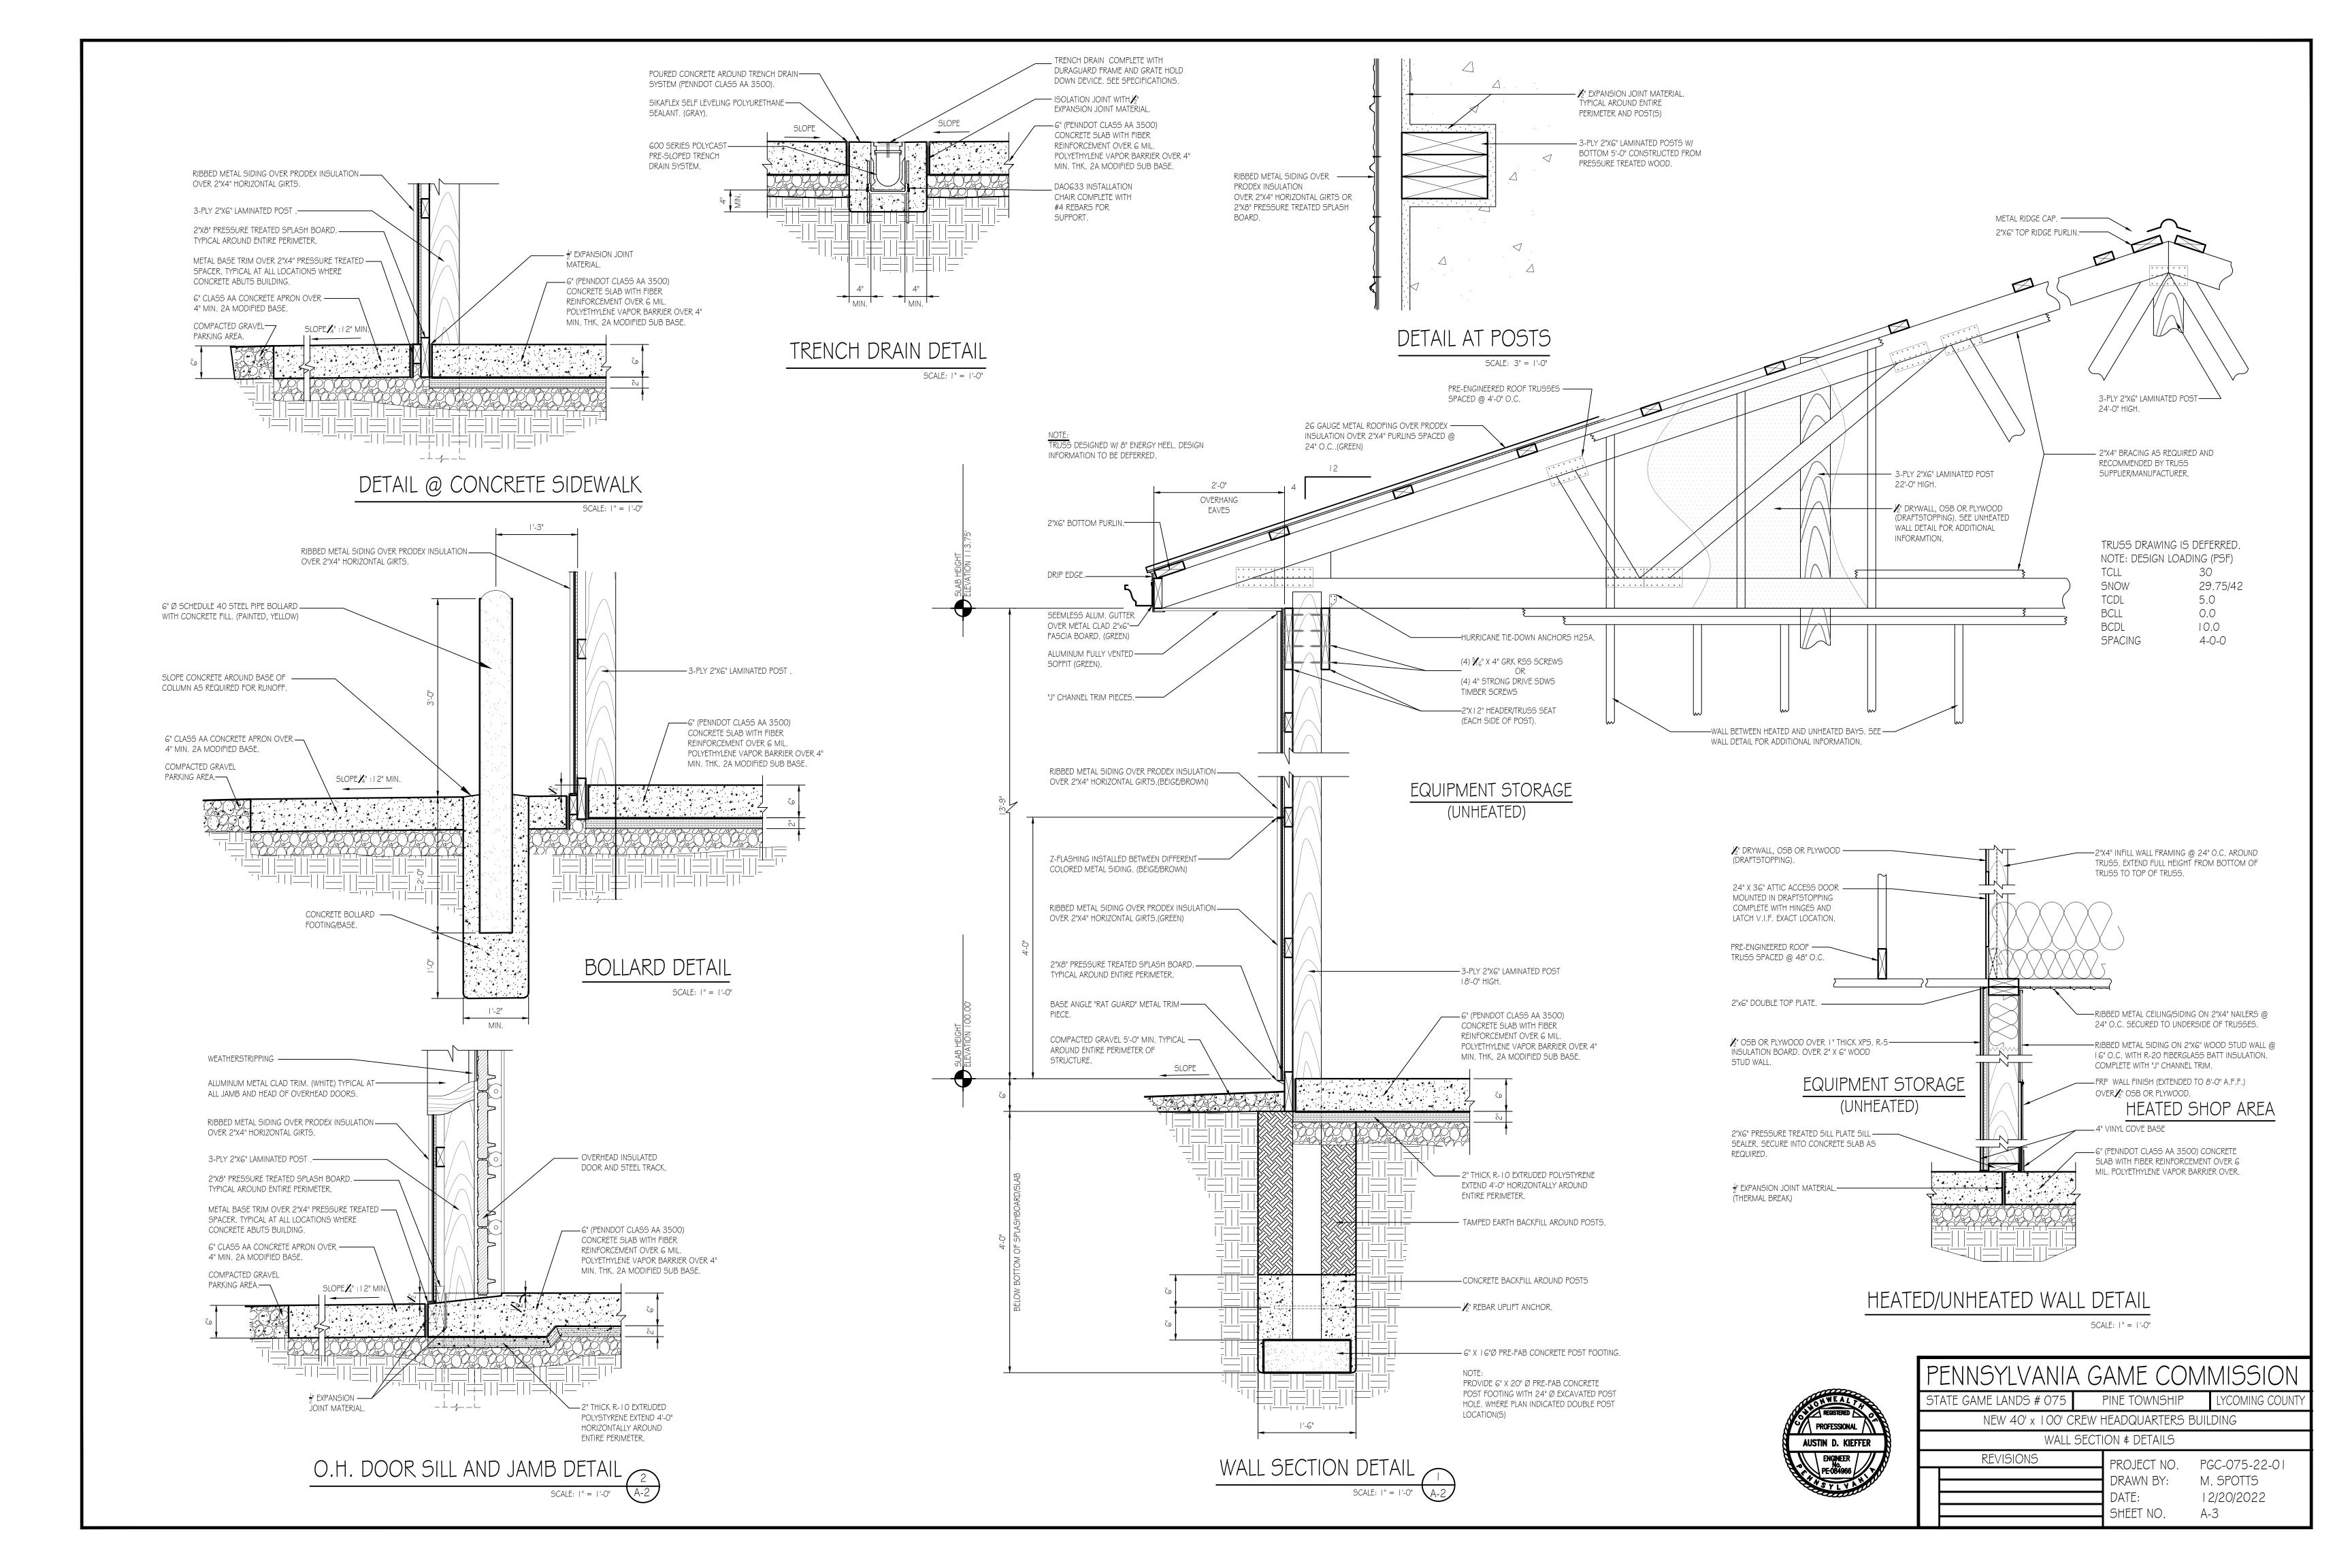

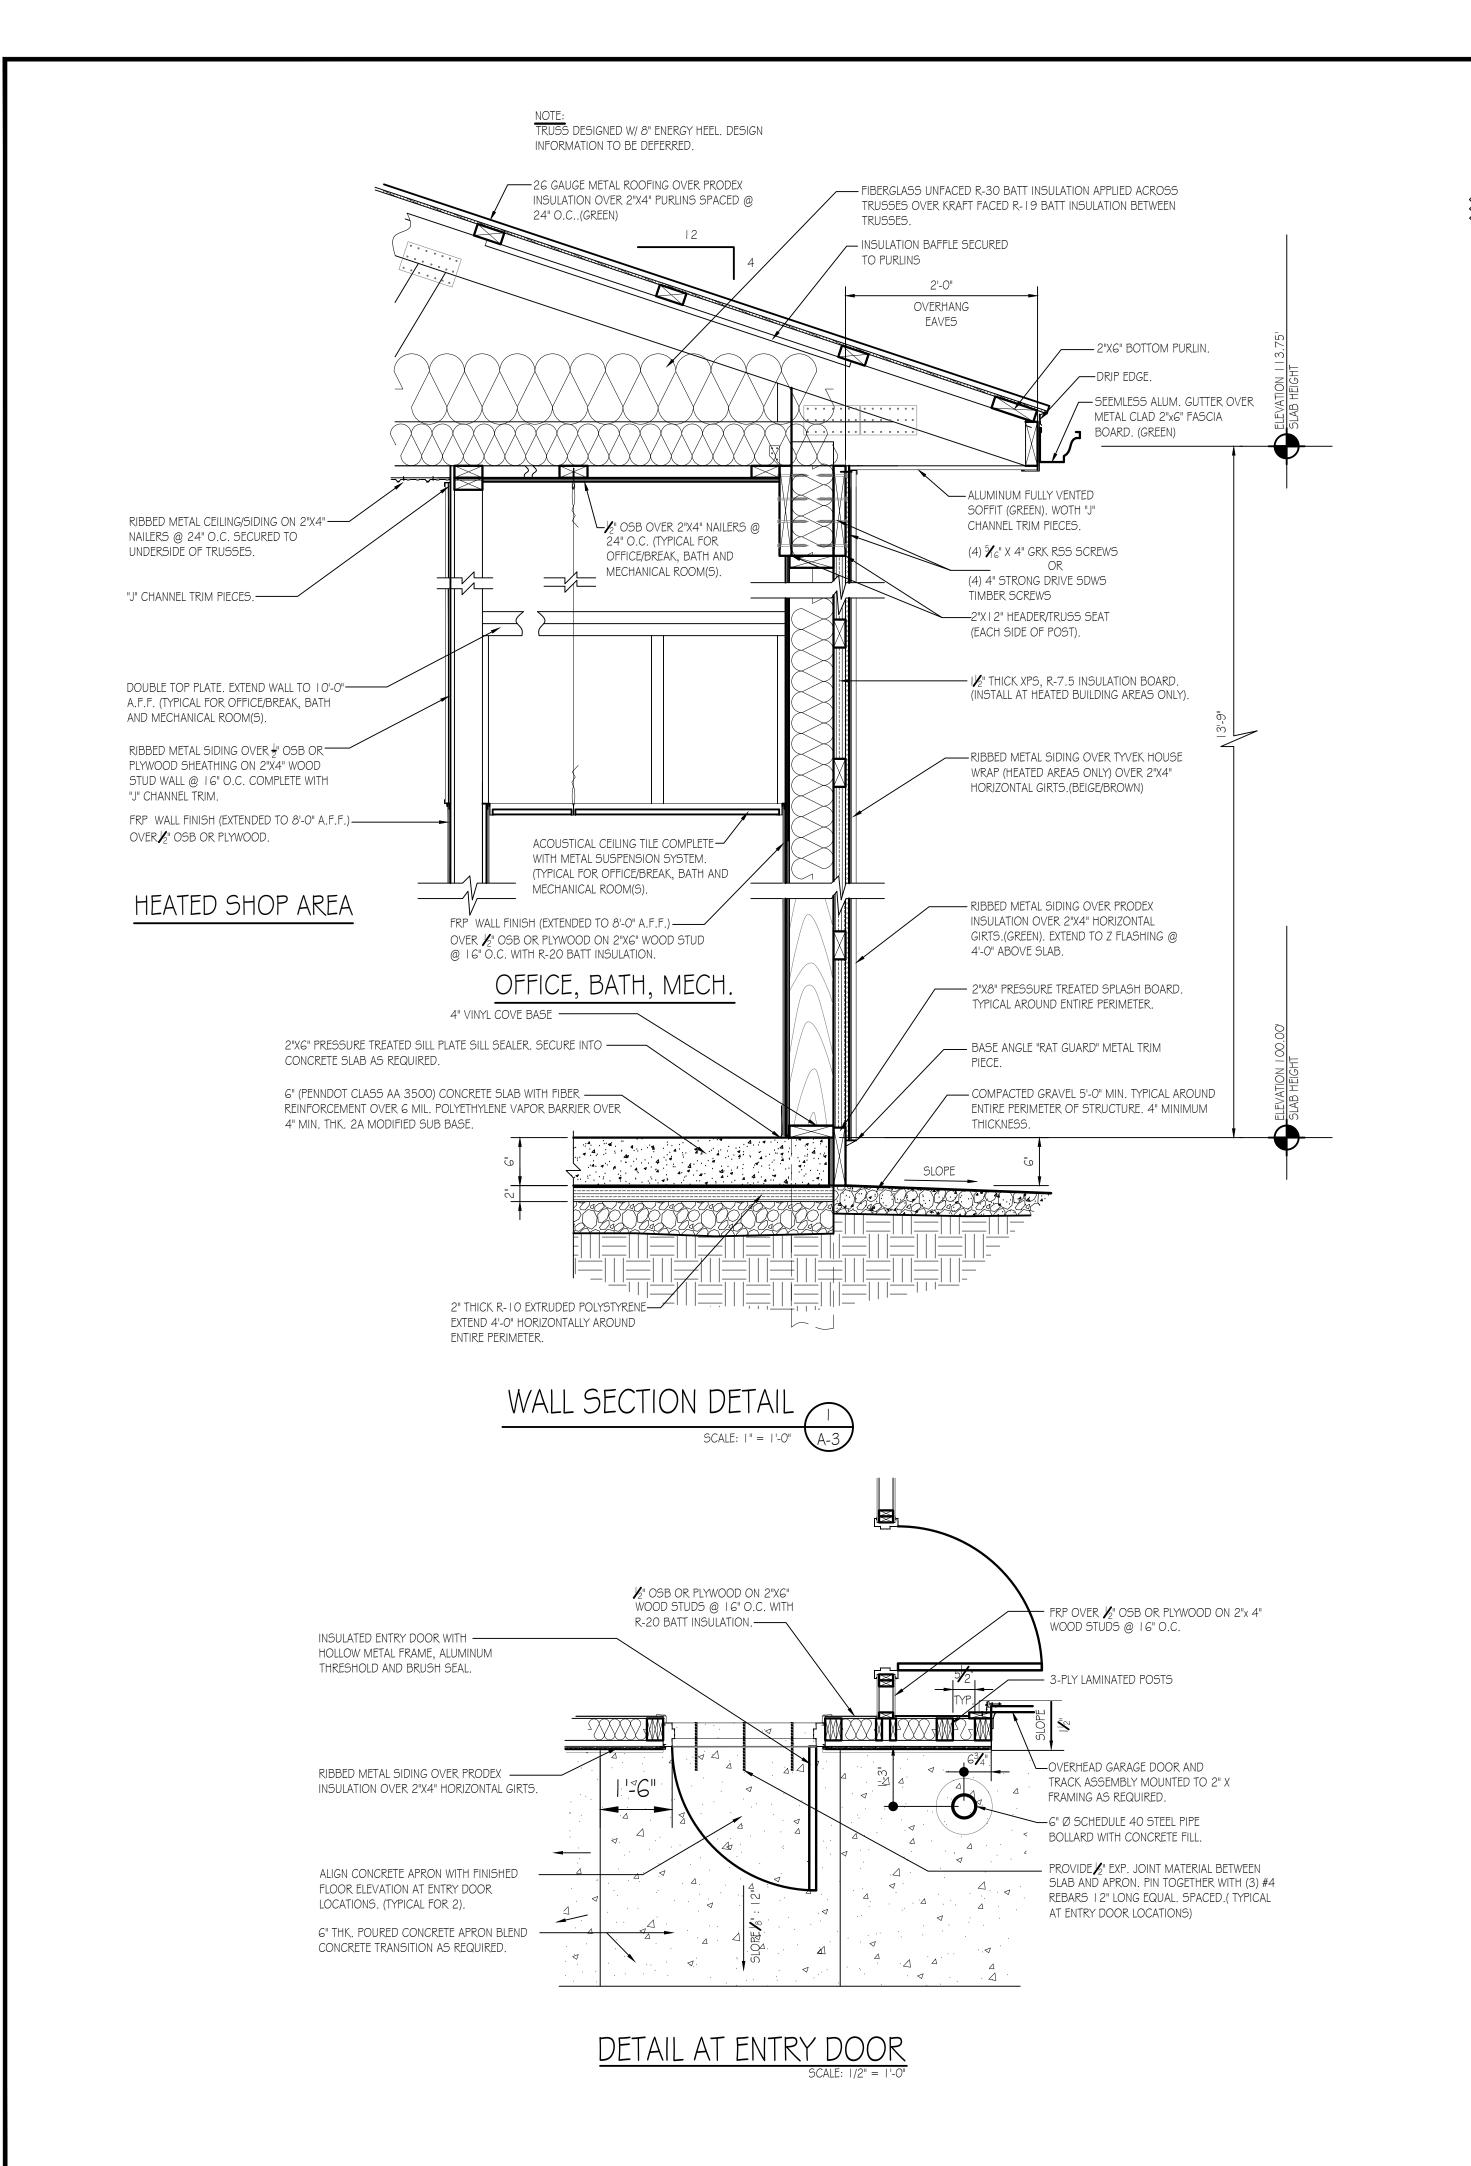

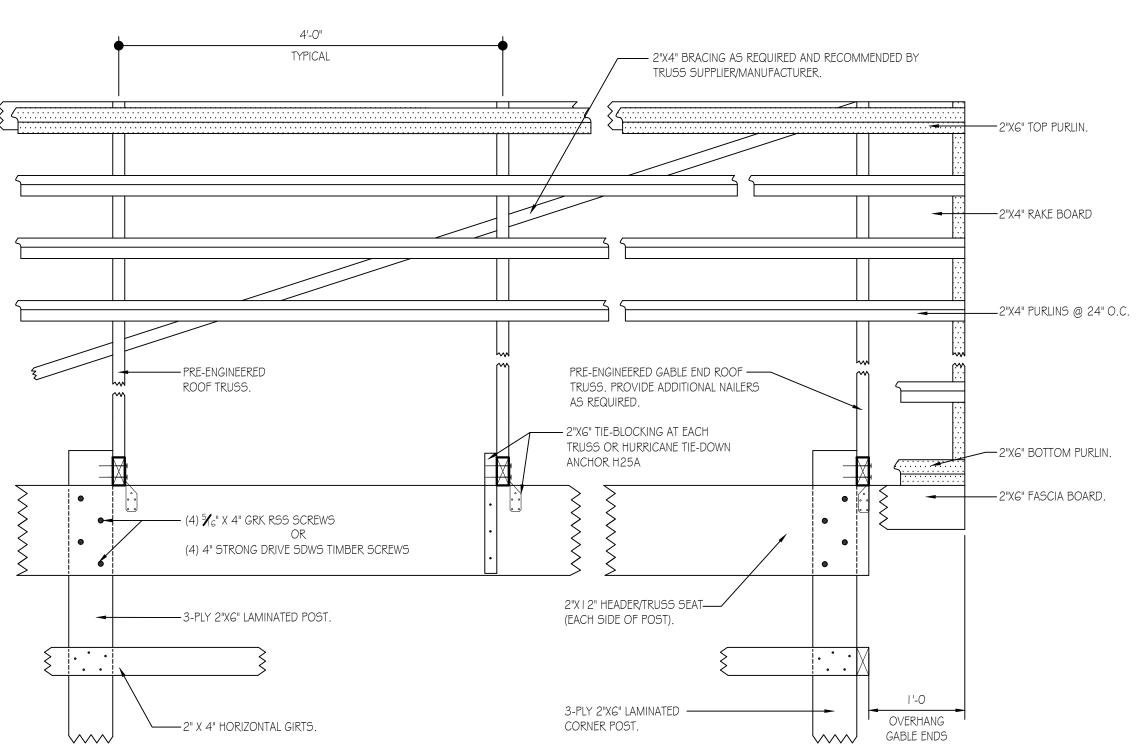
### TYPICAL ROOF FRAMING/BRACING DETAIL

SCALE: |" = |'-



#### GARAGE DOOR FRAMING DETAIL

SCALE: |" = |'-0"

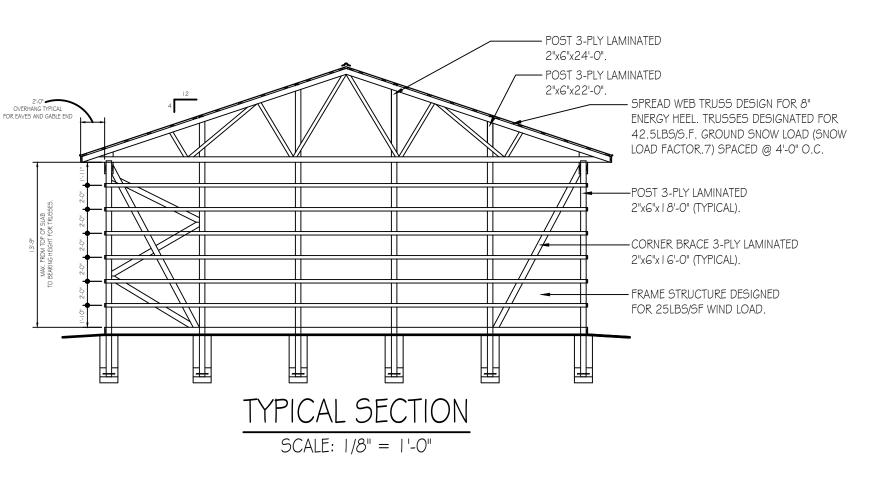



PENNSYLVANIA GAME COMMISSION							
STATE GAME LANDS # 075		PINE TOWNSHIP		LYCOMING COUNTY			
NEW 40' x 100' CREW HEADQUARTERS BUILDING							
SECTIONS & DETAILS							
REVISIONS		PROJECT NO.	PGC-075-22-01				


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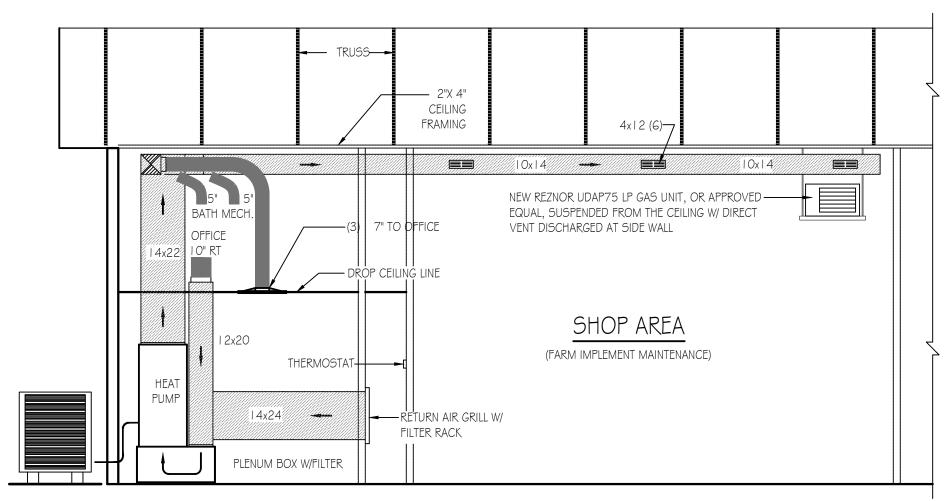
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M. SPOTTS

A-4

12/20/2022



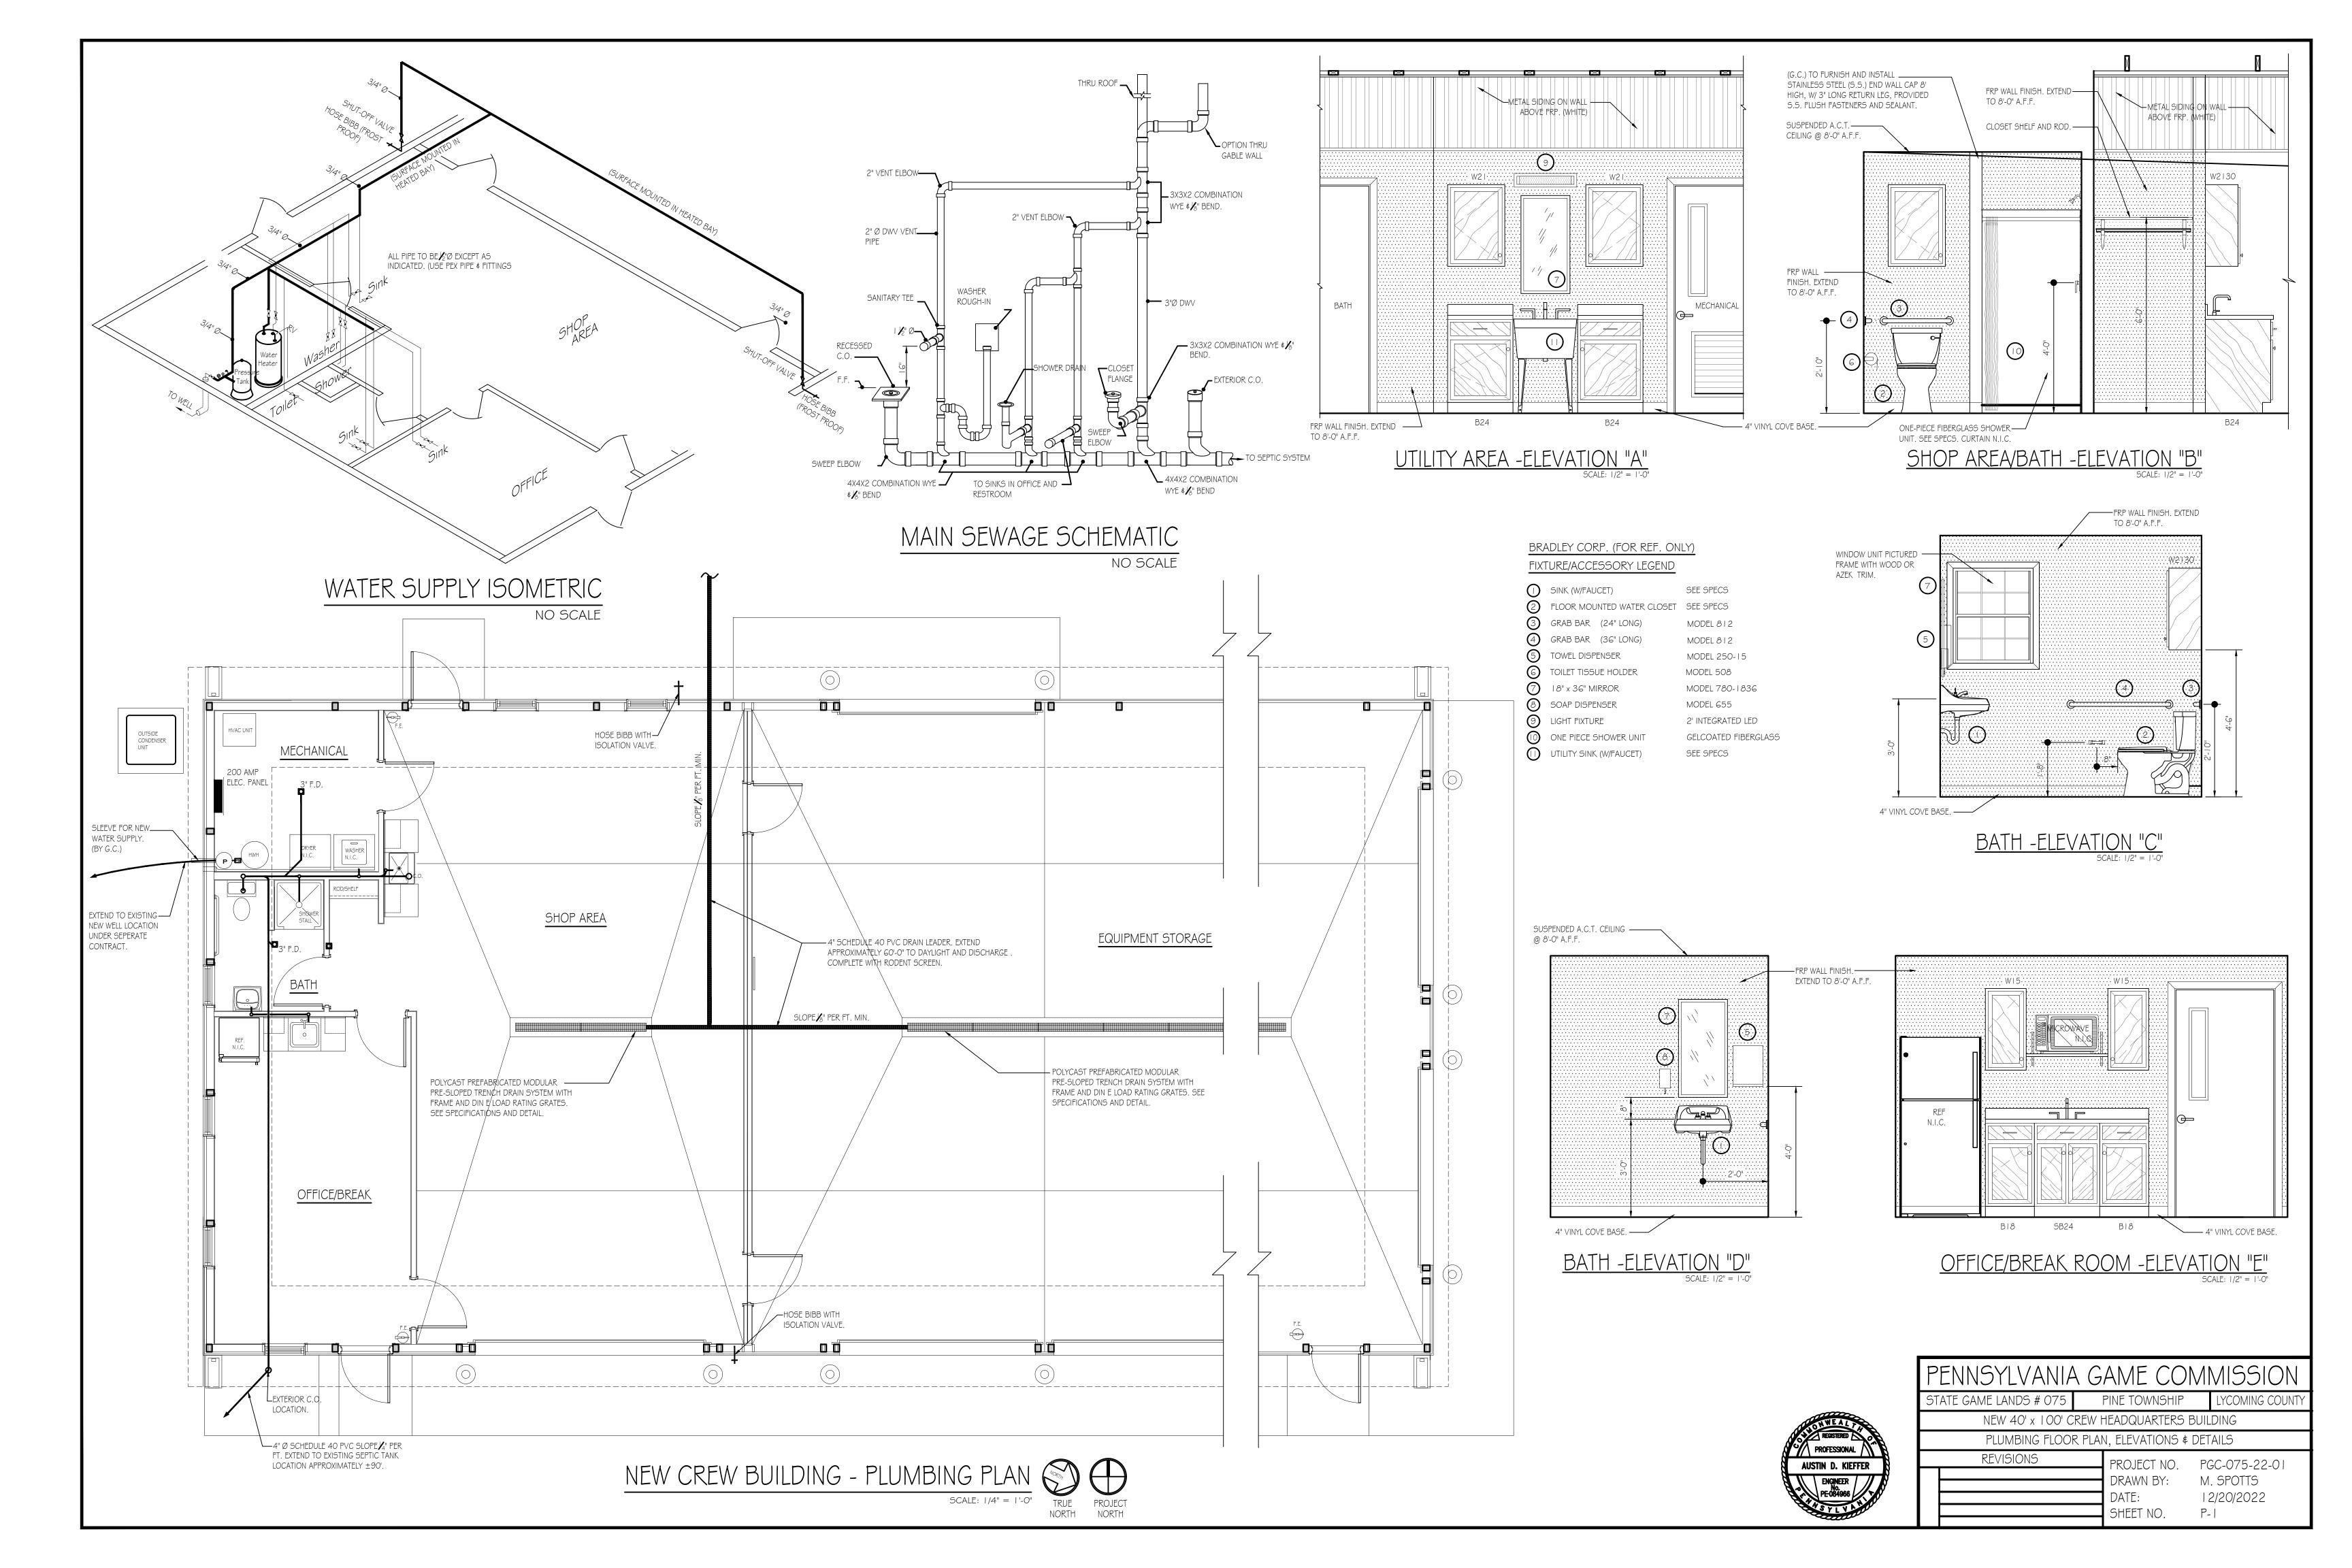

BUILDING SECTION - MECHANICAL SCALE: 1/4" = 1'-0"

#### MECHANICAL CONSTRUCTION NOTES:

HVAC SYSTEM TO BE A BOSCH HEAT PUMP SYSTEM. LAYOUT OF DUCTS, DUCT SIZES AND DIFFUSERS ARE MEANT TO BE USED AS A GUIDELINE.

ACTUAL RUNS, SIZES AND LOCATIONS TO BE DETERMINED BY MANUFACTURER'S MODEL. THE FOLLOWING STEPS SHOULD BE FOLLOWED IN THE DESIGN AND INSTALLATION OF THE HVAC SYSTEM TO ENSURE EFFICIENCY AND COMFORT.

I. DETERMINE ROOM-BY-ROOM AND AIR-FLOWS USING ACCA MANUAL J CALCULATION PROCEDURES. (OR SUBSTANTIALLY EQUIVALENT)


2. SIZE DUCT SYSTEM ACCORDING TO ACCA MANUAL D CALCULATION PROCEDURES. (OR SUBSTANTIALLY EQUIVALENT)

3. SIZE HVAC EQUIPMENT TO SENSIBLE LOAD USING ACCA MANUAL S CALCULATION PROCEDURES (OR SUBSTANTIALLY EQUIVALENT). 4. INSTALL EQUIPMENT & DUCTS ACCORDING TO DESIGN SPECIFICATIONS USING INSTALLATION PROCEDURES FROM SMACNA / MANUFACTURERS' SPECS.

5. INSTALL SO STATIC AIR PRESSURE DROP ACROSS THE AIR HANDLER IS WITHIN MANUFACTURER AND DESIGN SPECIFICATIONS.

6. PROVIDE BALANCED AIR FLOWS BETWEEN SUPPLY AND RETURN SYSTEMS TO MAINTAIN NEUTRAL PRESSURE.

7. EQUIPMENT AND ASSOCIATED ITEMS MUST BE APPROVED BY PGC HARRISBURG ENGINEERING DIVISION BEFORE START OF INSTALLATION. HEAT PUMP TO BE A 5 TON BOSCH BOVA - 060-HDN I - M I 8M OUTSIDE CONDENSER UNIT W/ BGH9GM I 00C5B AIR HANDLER/FURNACE AND BMAC4860CNTF CASE COIL. UNITS TO ACHIEVE A MINIMUM 17 SEER AND 9.5 HSPF (OR SUBSTANTIALLY EQUIVALENT). SEE SPECIFICATIONS.

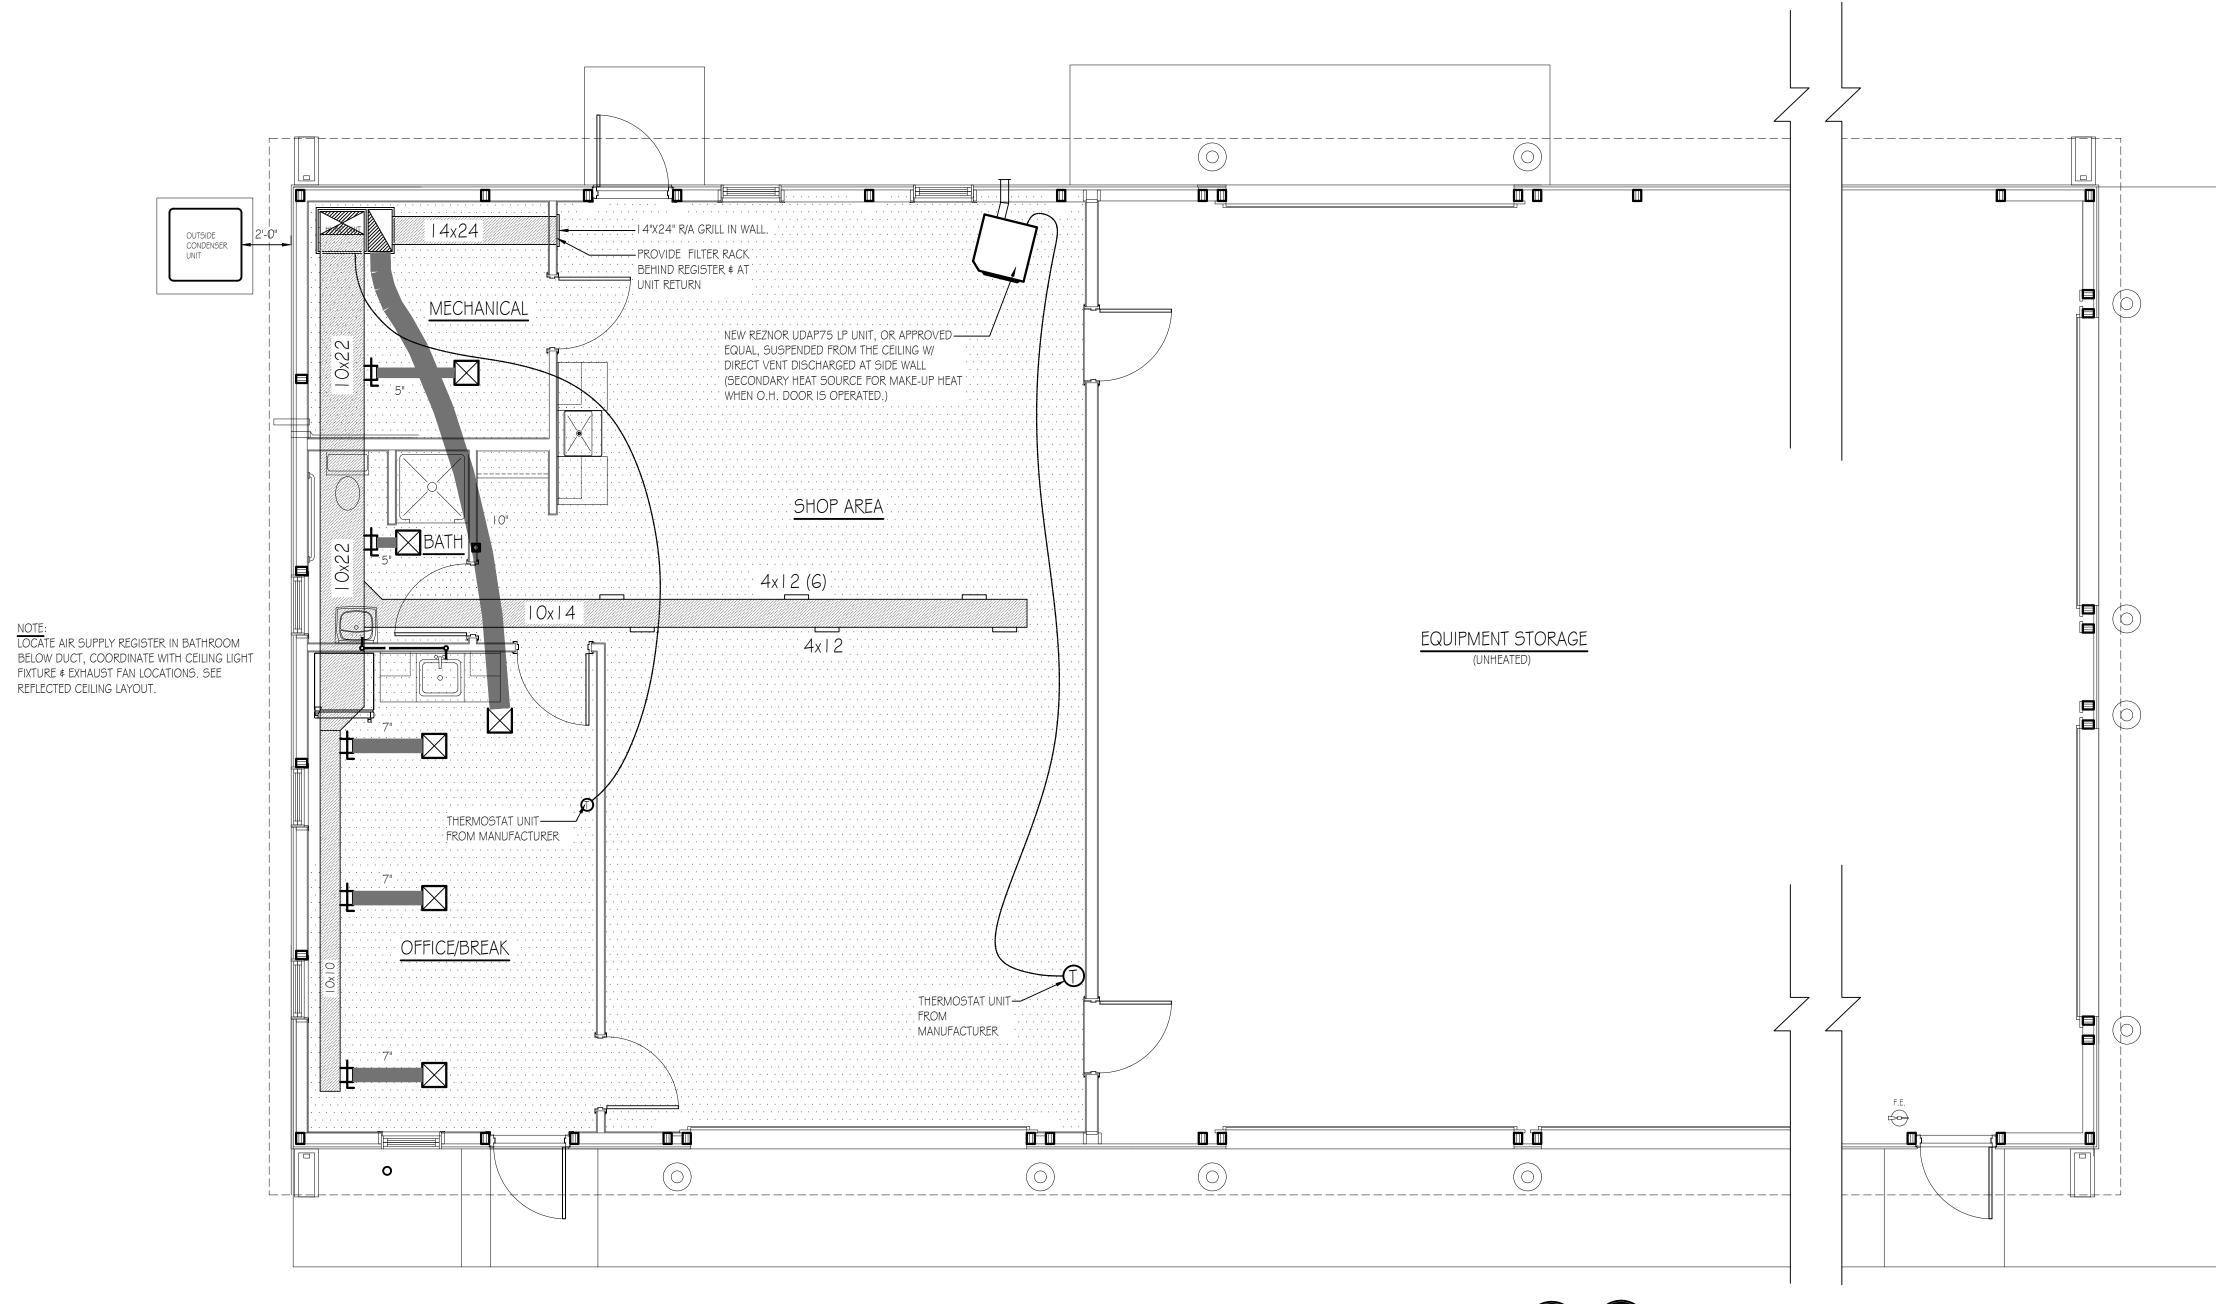



PENNSYLVANIA GAME COMMISSION NEW 40' x 100' CREW HEADQUARTERS BUILDING

> MECHANICAL FLOOR PLAN AND DETAILS REVISIONS

PROJECT NO. PGC-075-22-01 DRAWN BY: M. SPOTTS 12/20/2022 SHEET NO.

NEW CREW BUILDING - PLUMBING PLAN

SCALE: 1/4" = 1'-0"

TRUE PROJECT NORTH



